

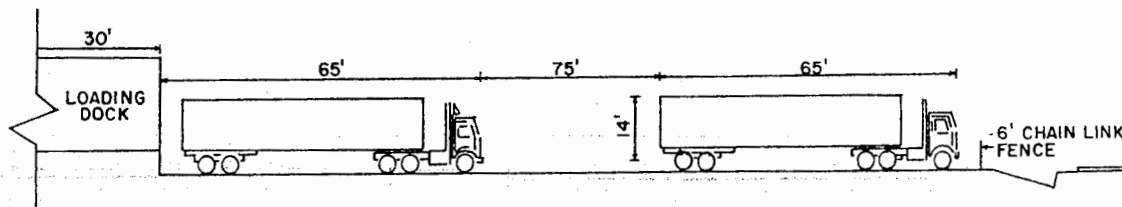
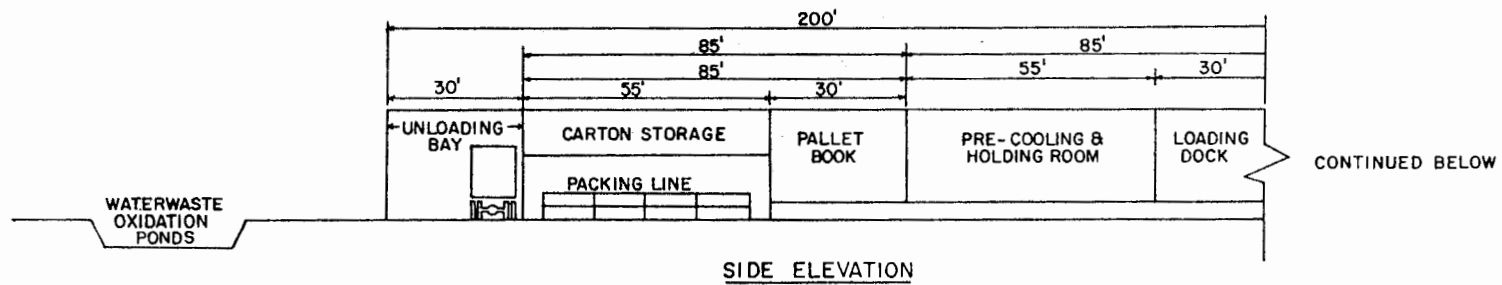



FLOW DIAGRAM
SCHEMATIC

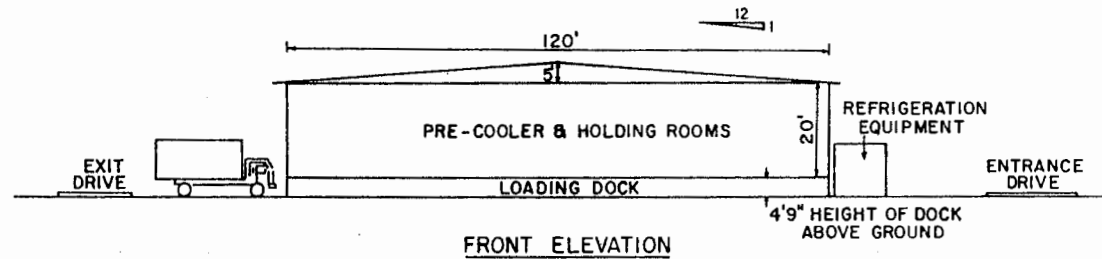


PACKING & COOLING FACILITY
1,200 ACRES

ENGINEER	BRANCH	SCALE 1" = 40'-0"
DRAWN BY	NICHOLS	SHEET 1 OF 5
TRACED BY	NICHOLS	DATE 5-'86 84-04

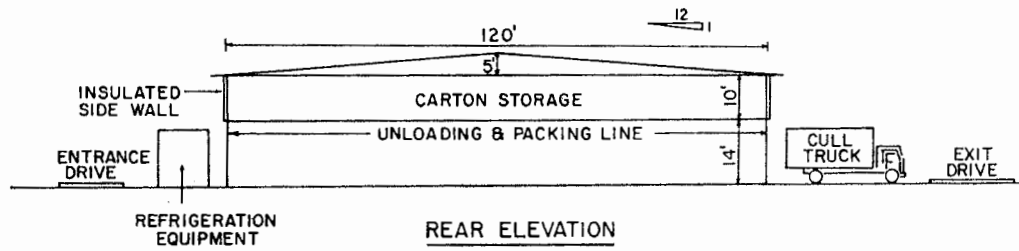

		
PACKING & COOLING FACILITY 1,200 ACRES		
ENGINEER	BRANCH	SCALE 1" = 20'-0"
DRAWN BY	NICHOLS	SHEET 2 OF 5
TRACED BY	NICHOLS	DATE 5-86 NO. 84-04

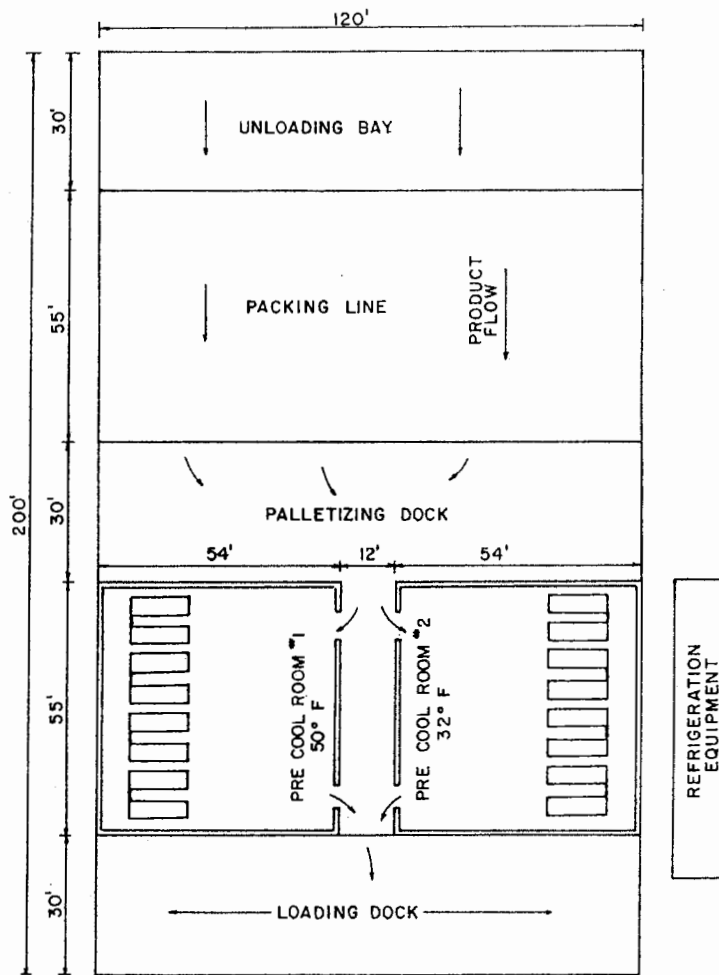


PLANT FLOOR PLAN



PACKING & COOLING FACILITY
1,200 ACRES

ENGINEER	BRANCH	SCALE	1" = 20'-0"
DRAWN BY	NICHOLS	SHEET	3 OF 5
TRACED BY	NICHOLS	DATE	5-'86
		NO.	84-04



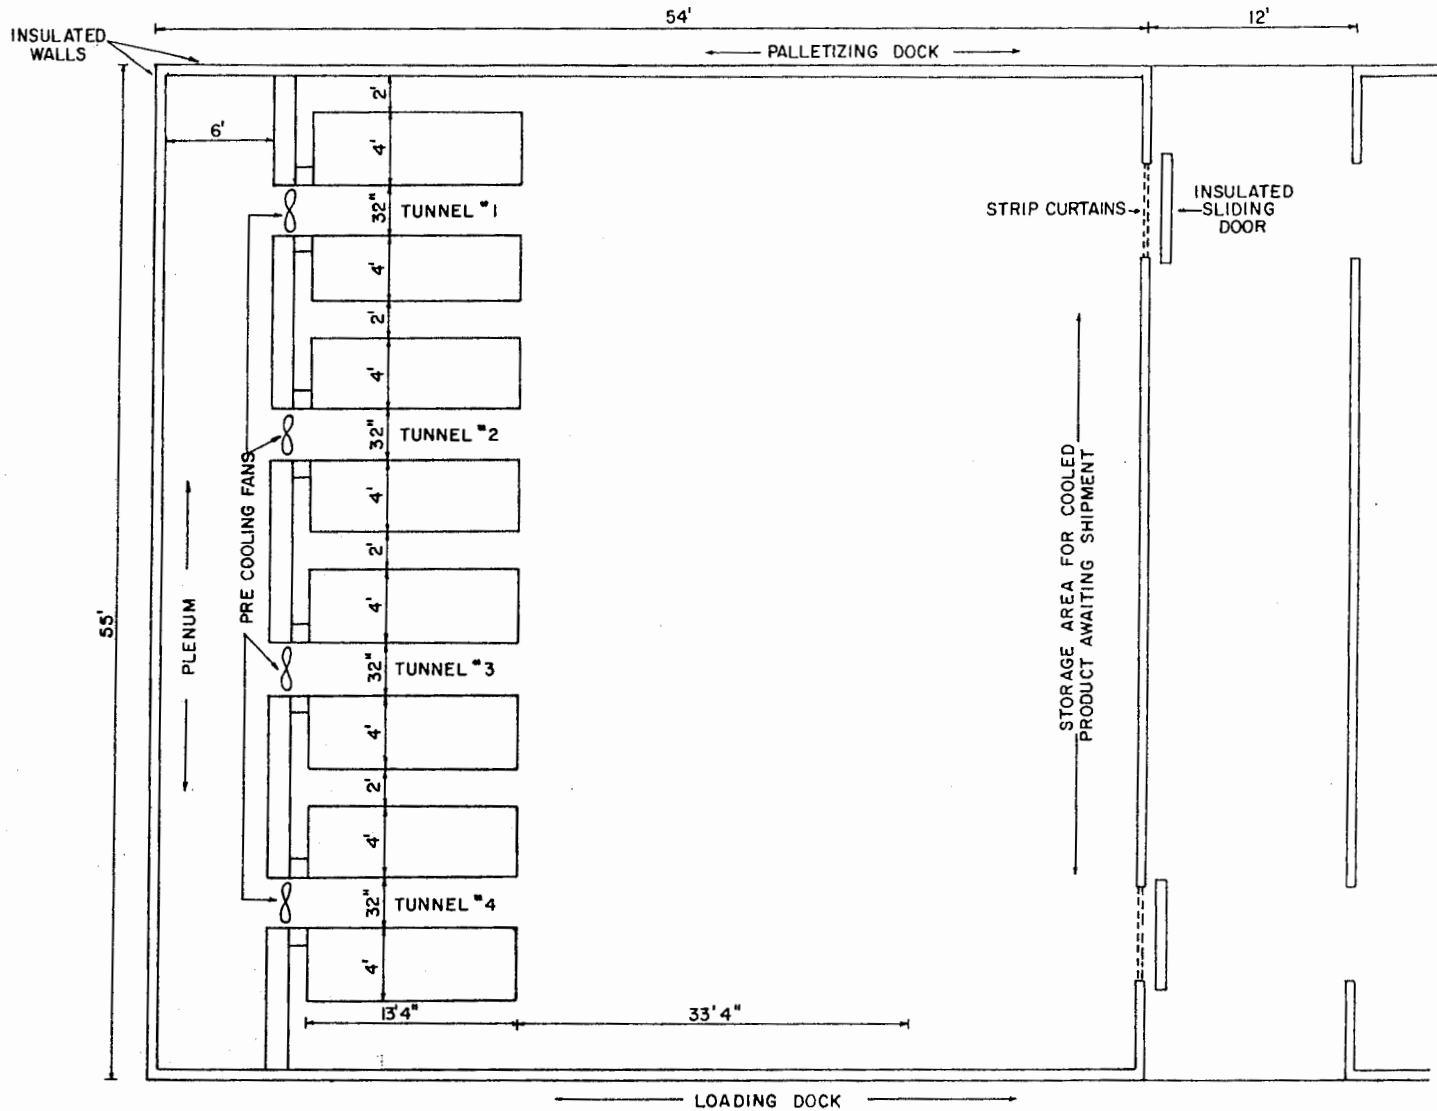


FLOOR PLAN
PRE COOLING ROOM #1



PACKING & COOLING FACILITY
1,200 ACRES

ENGINEER	BRANCH	SCALE	1" = 20'-0"
DRAWN BY	NICHOLS	SHEET	4 OF 5
TRACED BY	NICHOLS	DATE	5-'86 NO. 84-04

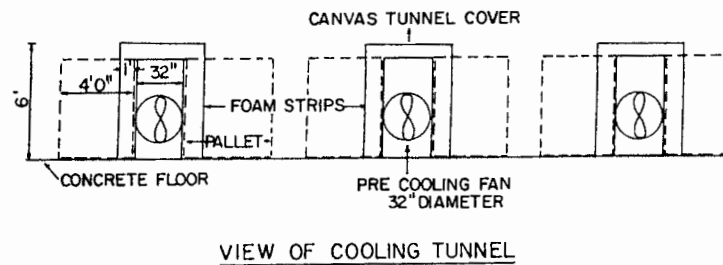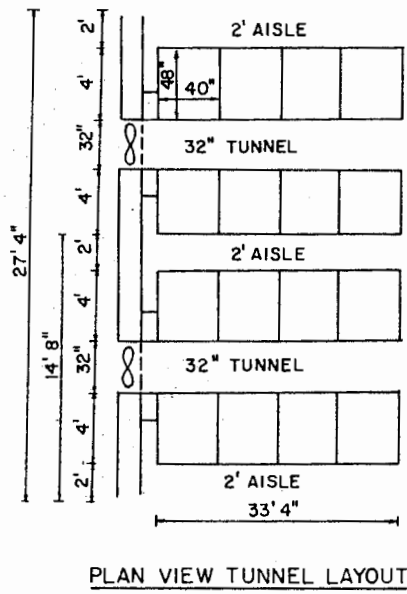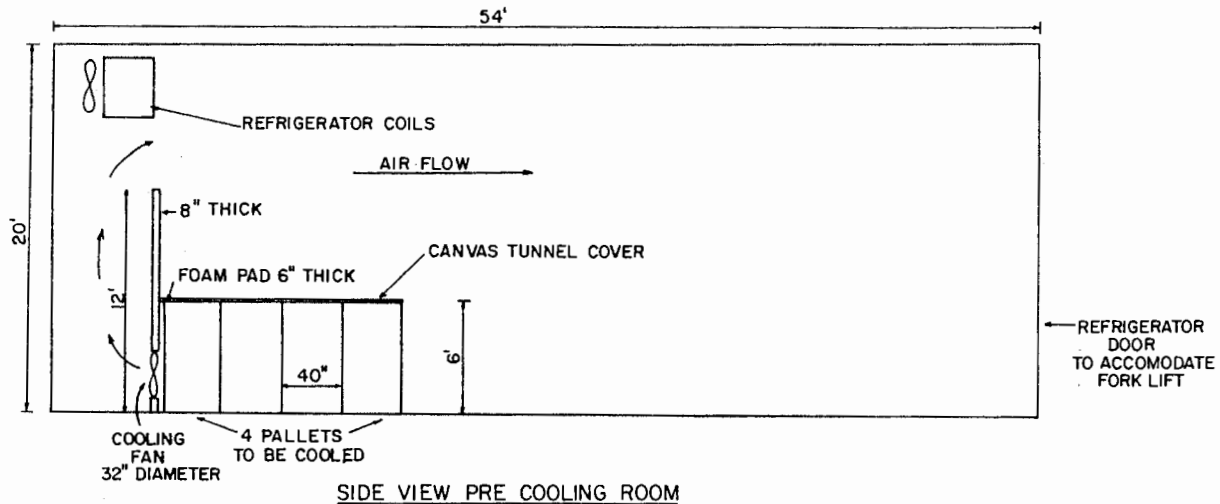

ONE TUNNEL COOLS 8 PALLETS OR UP TO 20 TONS OF PRODUCE AT ONE TIME



PACKING & COOLING FACILITY		
1,200 ACRES		
ENGINEER	BRANCH	SCALE 1" = 5'-0"
DRAWN BY	NICHOLS	SHEET 5 OF 5
TRACED BY	NICHOLS	DATE 5-'86 NO. 84-04

Disclaimer

This site makes available conceptual plans that can be helpful in developing building layouts and selecting equipment for various agricultural applications. These plans do not necessarily represent the most current technology or construction codes. They are not construction plans and do not replace the need for competent design assistance in developing safe, legal and well-functioning agricultural building system. The LSU Agriculture Center, the Mid-West Plan Service, the United States Department of Agriculture and none of the cooperating land-grant universities warranty these plans.