

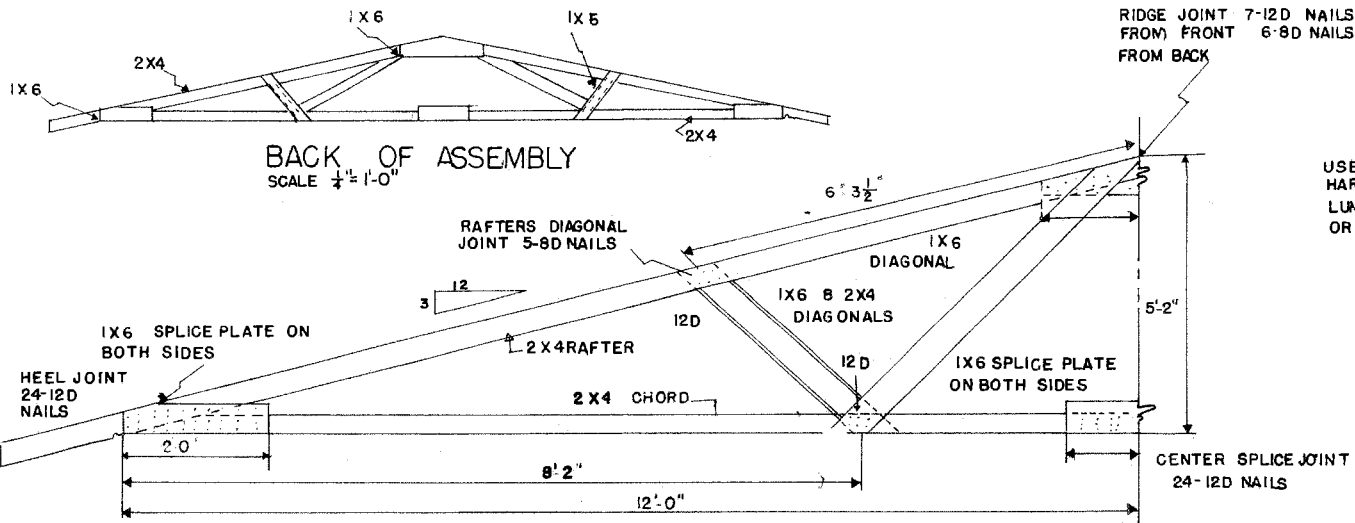


FLOOR PLAN SCALE  $\frac{1}{4}'' = 1'-0''$


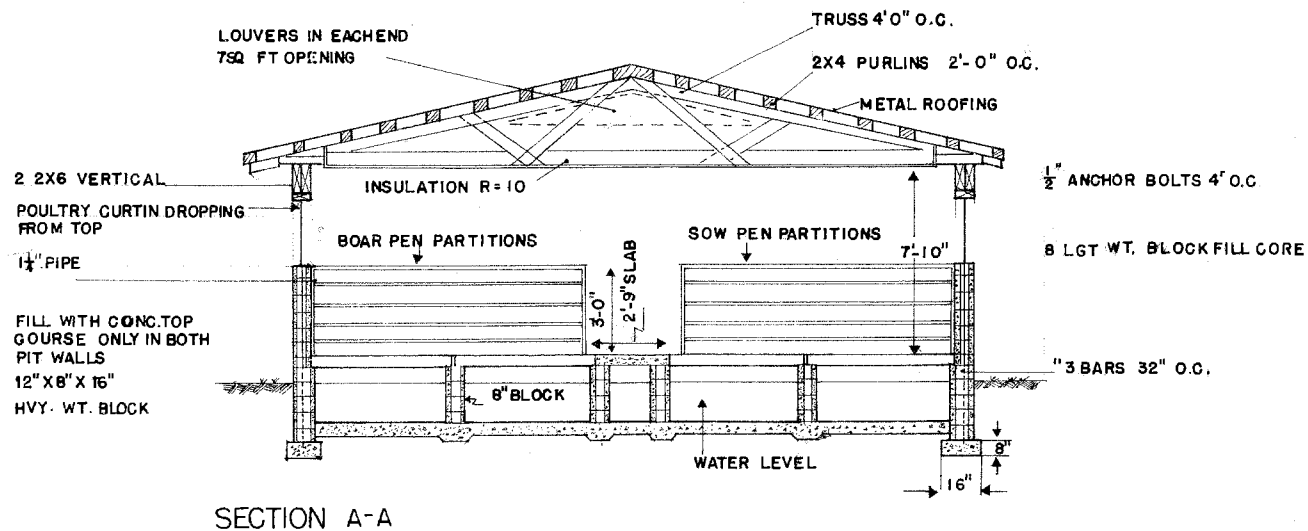


SECTION A-A

	
<b>SWINE BREEDING BLDG. CONTROLLED ENVIRONMENT</b>	
ENGINEER <b>GENE BAKER</b>	SCALE $\frac{1}{4}'' = 1'-0''$
DRAWN BY <b>R.F.</b>	SHEET <b>1</b> OF <b>3</b>
TRACED BY	DATE <b>12-75</b> NO. <b>54-11</b>




USE HELICALLY THREADED HARDED NAIL THROUGHOUT LUMBER NO SOUTHERN PINE OR EQUIVALENT

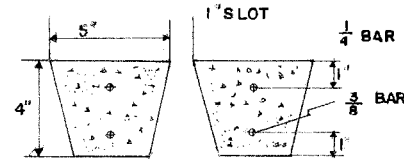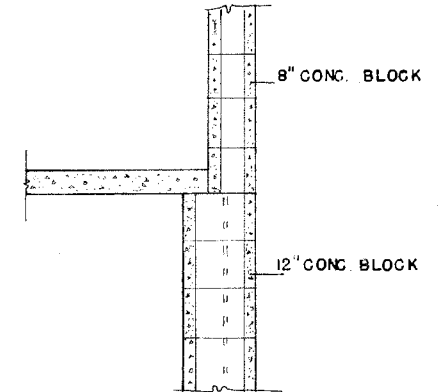


CONCRETE SLAT DETAIL  
SCALE 3" = 1'-0"

SCALE  $\frac{3}{4}$ " = 1'-0"

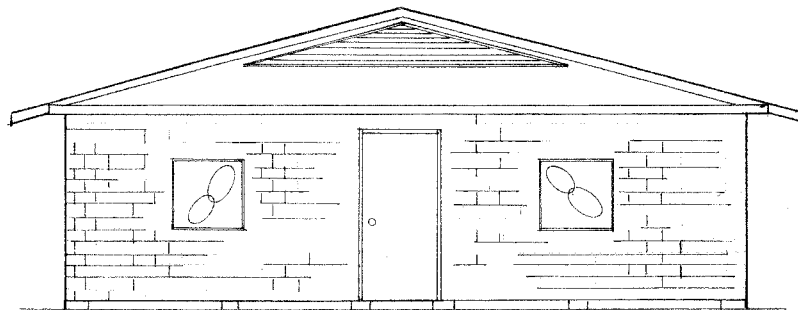

LEFT ELEVATIONS  
SCALE  $\frac{1}{4}$ " = 1'-0"

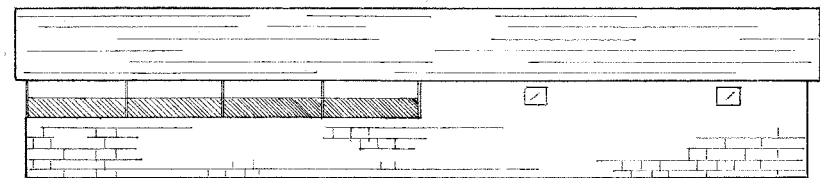



RIGHT SIDE ELEVATION  
SCALE  $\frac{1}{8}$ " = 1'-0"



SWINE BREEDING BLDG.  
CONTROLLED ENVIRONMENT

ENGINEER GENE BAKER	SCALE AS SHOWN
DRAWN BY R.F.	SHEET 2 OF 3
TRACED BY	DATE 12-75 NO. 54-11

5000 CFM. VENT FAN  $\frac{1}{8}$ " "STATIC PRESSURE"

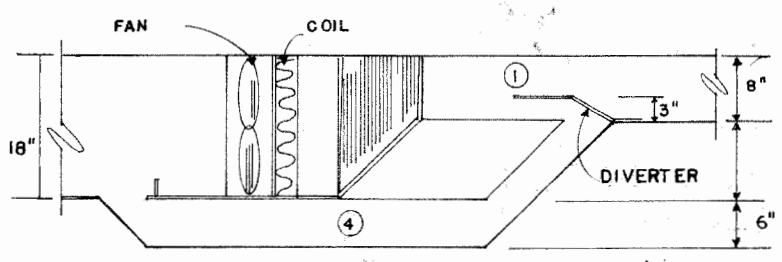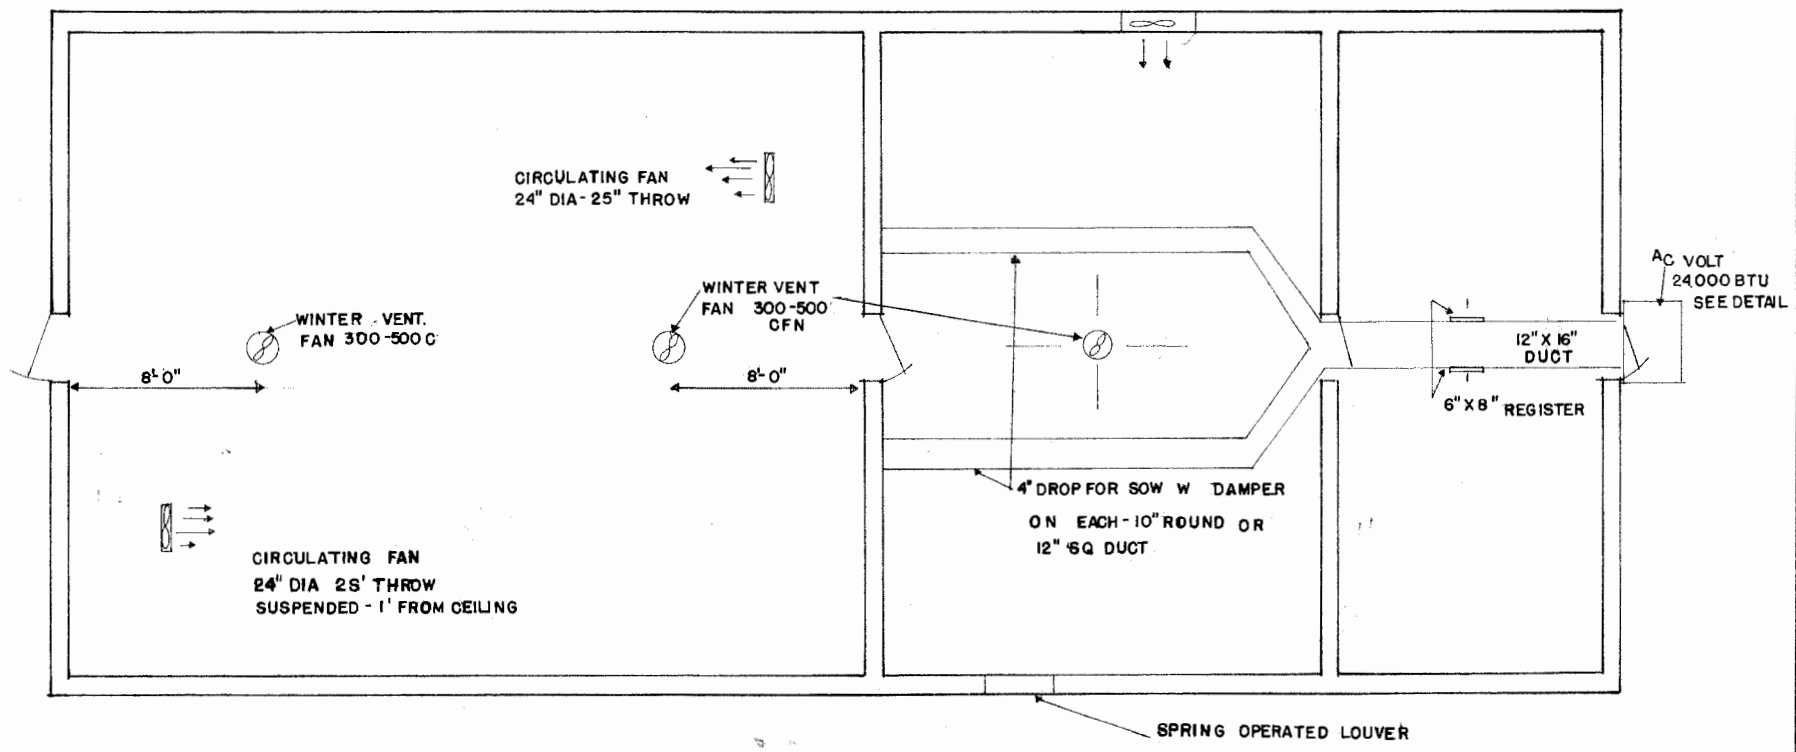

NOTE  
DUCT SIZES CORRESPONDES  
TO DUCT SCHEDULE

DETAIL OF AC DIVERTER  
SCALE 1" = 1'-0"



SWINE BREEDING BLD.  
CONTROLLED ENVIRONMENT

ENGINEER G B	SCALE $\frac{1}{4}$ " = 1'-0"
DRAWN BY R.F.	SHEET 3 OF 3
TRACED BY	DATE 12-75 NO 54-11

## Disclaimer

This site makes available conceptual plans that can be helpful in developing building layouts and selecting equipment for various agricultural applications. These plans do not necessarily represent the most current technology or construction codes. They are not construction plans and do not replace the need for competent design assistance in developing safe, legal and well-functioning agricultural building system. The LSU Agriculture Center, the Mid-West Plan Service, the United States Department of Agriculture and none of the cooperating land-grant universities warranty these plans.