



PERSPECTIVE

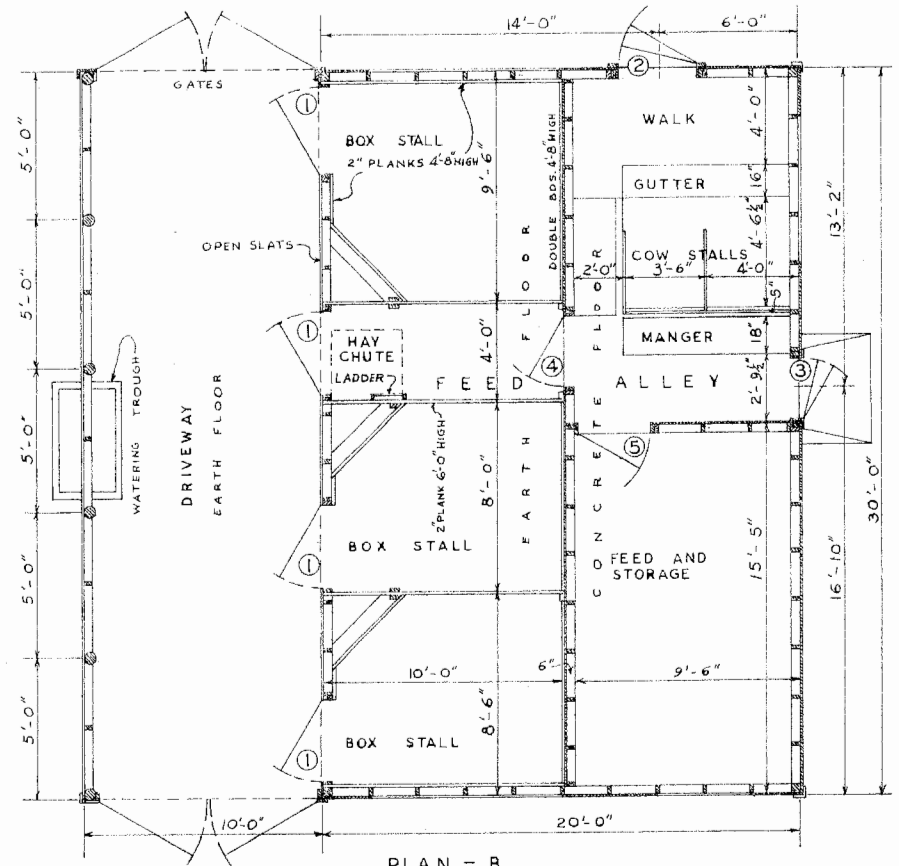


PLAN - B

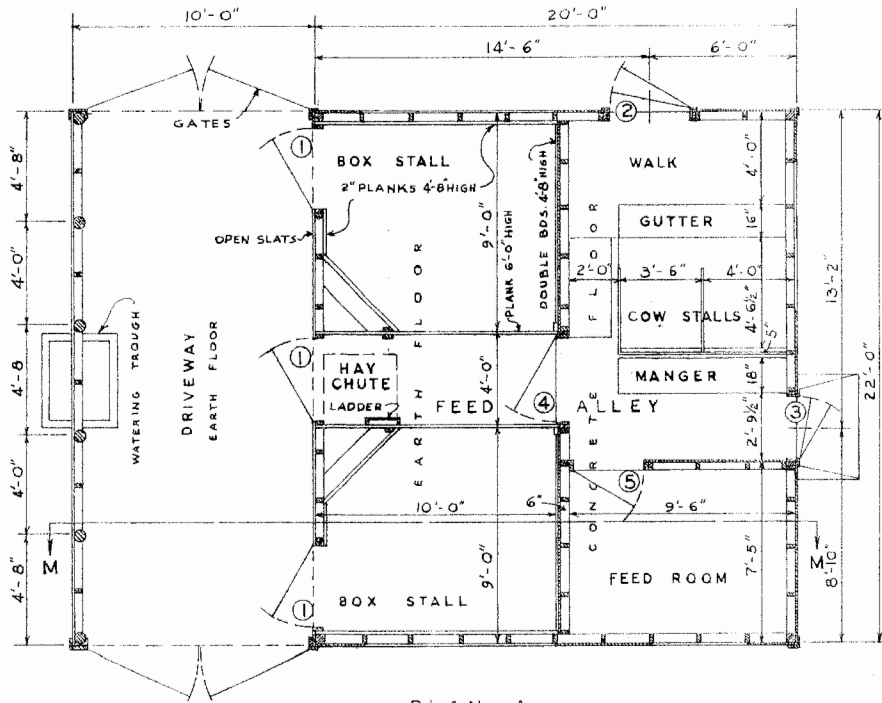

PLAN - A

FOR LARGE HORSES INCREASE SIZE OF STALLS

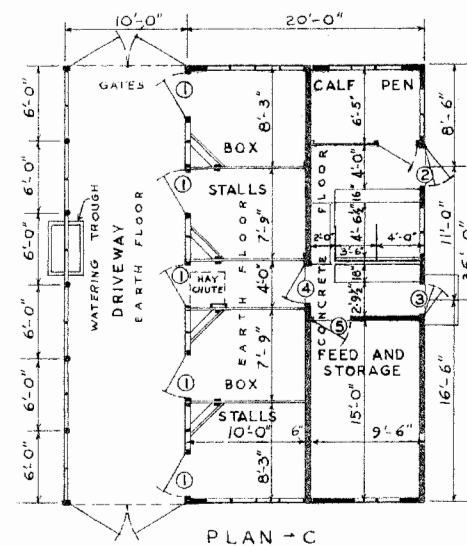

PLAN - C


DOOR SCHEDULE

- ① 3'-6" x 7'-4" BATTEN DOOR (TOP OPEN SLATS)
- ② 3'-6" x 7'-4" " " (DUTCH DOORS)
- ③ 2'-6" x 6'-7" " " " "
- ④ 3'-6" x 7'-4" " " " "
- ⑤ 3'-0" x 6'-7" " " " "




GENERAL BARN AND LEAN-TO


| | | | |
|-----------|--------|-------|----------|
| ENGINEER | S. C. | SCALE | AS SHOWN |
| DRAWN BY | | SHEET | 1 OF 2 |
| TRACED BY | H.B.M. | DATE | NO. 44-3 |

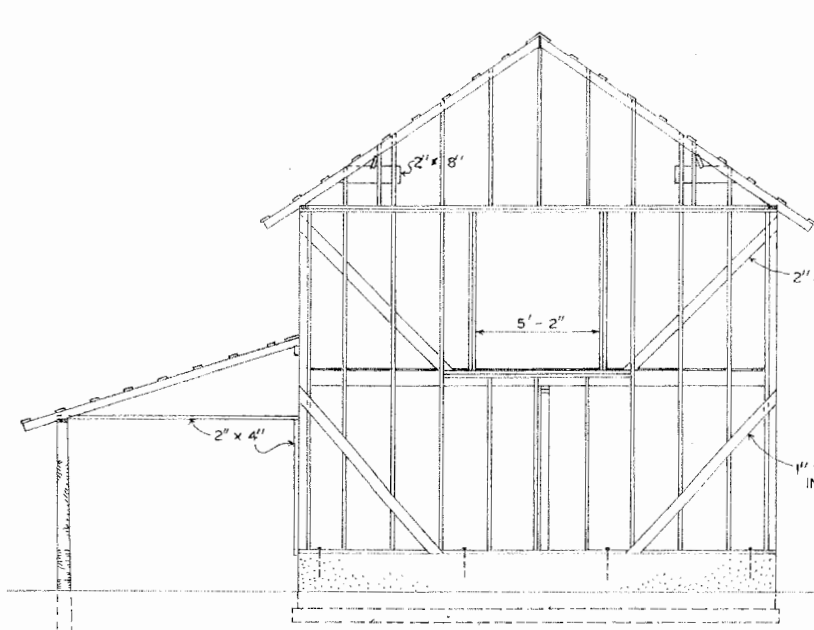


END FRAMING DETAIL
SCALE $\frac{1}{4}'' = 1'-0''$

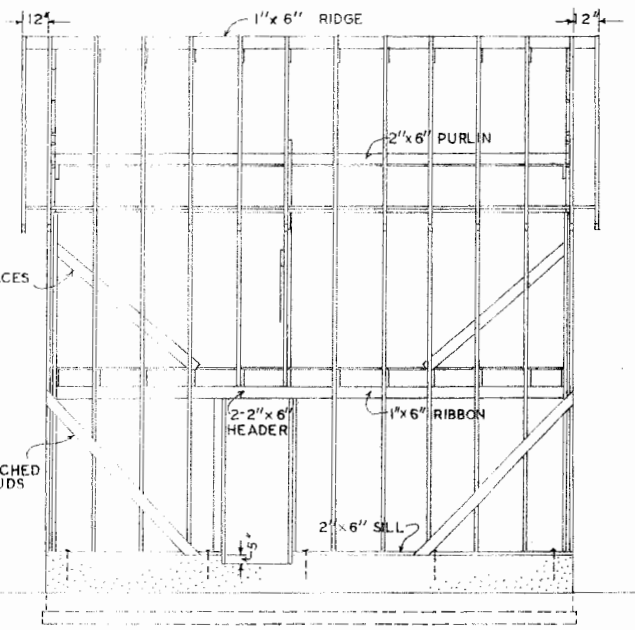


SIDE FRAMING DETAIL
SCALE $\frac{1}{4}'' = 1'-0''$

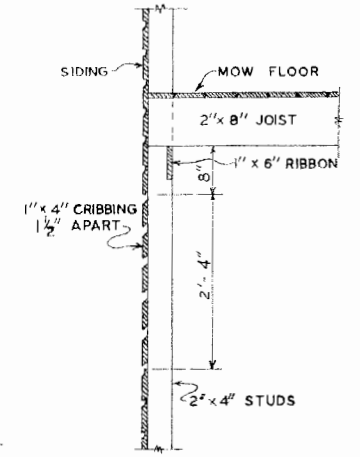

SIDE WALL SHOWING
SLATTED OPENINGS

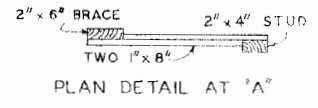


PLAN DETAIL AT 'A'

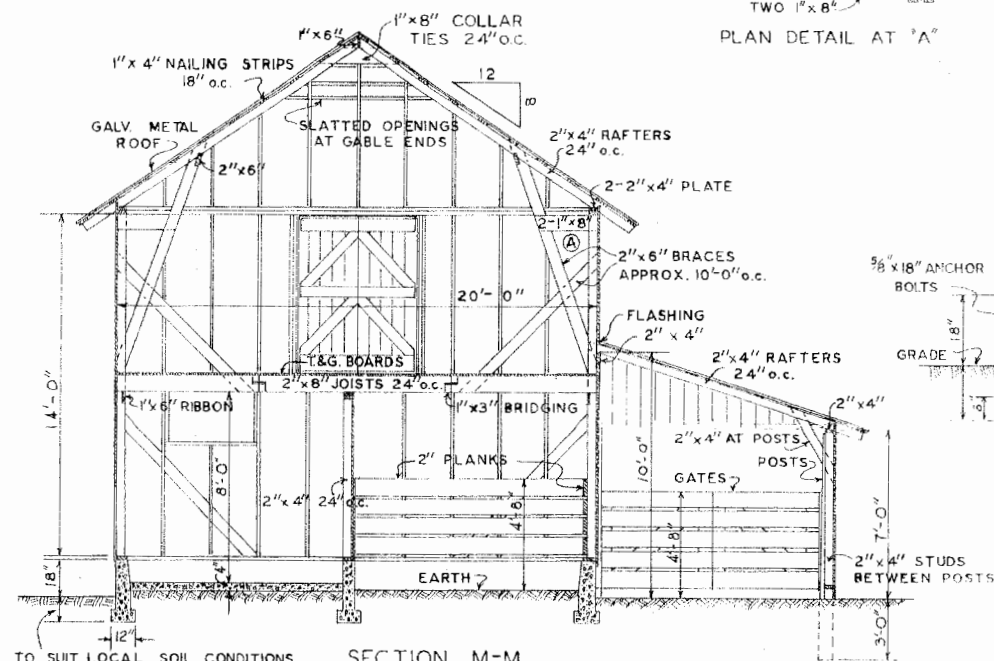

SECTION M-M
SCALE $\frac{1}{4}'' = 1'-0''$

TO SUIT LOCAL SOIL CONDITIONS

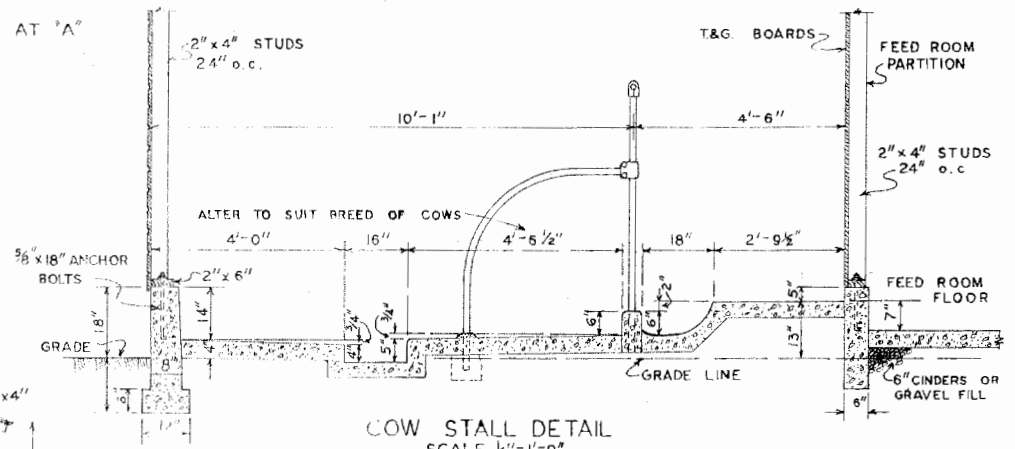

COW STALL DETAIL
SCALE $\frac{1}{2}'' = 1'-0''$



GENERAL BARN AND LEAN-TO

| | |
|------------------|----------------|
| ENGINEER S.C. | SCALE AS SHOWN |
| DRAWN BY | SHEET 2 OF 2 |
| TRACED BY H.B.M. | DATE |
| | NO. 44-3 |

Disclaimer

This site makes available conceptual plans that can be helpful in developing building layouts and selecting equipment for various agricultural applications. These plans do not necessarily represent the most current technology or construction codes. They are not construction plans and do not replace the need for competent design assistance in developing safe, legal and well-functioning agricultural building system. The LSU Agriculture Center, the Mid-West Plan Service, the United States Department of Agriculture and none of the cooperating land-grant universities warranty these plans.